

REVISIONS	DATE	BY
1	10-11-12	AW
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3		

SITE PLAN GENERAL NOTES

- UTILITY POINTS OF SERVICE AND WORK/MATERIAL SHOWN ARE BASED UPON PRELIMINARY INFORMATION ONLY BY THE UTILITY COMPANIES AND ARE FOR BID PURPOSES ONLY.
- CONTRACTOR SHALL COORDINATE WITH THE UTILITY COMPANY FOR FINAL AND EXACT WORK/MATERIAL REQUIREMENTS AND CONSTRUCT TO UTILITY COMPANY ENGINEERING PLANS AND SPECIFICATIONS ONLY. CONTRACTOR SHALL FINISH AND INSTALL ALL CONDUIT, PULL WIRES, CABLES, PULLBOXES, CONCRETE ENCASMENT OF CONDUITS, TRANSFORMER PAD, BARRIERS, POLE RISERS, TRENCHING AND BACKFILL AND PAY ALL UTILITY CO. FEES AND INCLUDE ALL REQUIREMENTS IN SCOPE OF WORK.
- LOCATIONS OF UTILITIES SHOWN ARE APPROXIMATE AND CONTRACTOR SHALL EXERCISE EXTREME CAUTION IN EXCAVATING AND TRENCHING ON THIS SITE TO AVOID EXISTING DUCTS, PIPING OR CONDUITS ETC., AND TO PREVENT HAZARD TO PERSONNEL AND/OR DAMAGE TO EXISTING UNDERGROUND UTILITIES OR STRUCTURES WHETHER OR NOT SHOWN AND INSTALLED BY ANY OTHER CONTRACTORS. THE ENGINEER IS NOT RESPONSIBLE FOR THE LOCATION OF UNDERGROUND UTILITIES OR STRUCTURES WHETHER OR NOT SHOWN OR DETAILED AND IMMEDIATELY NOTIFY THE ENGINEER SHOULD SUCH UNIDENTIFIED CONDITIONS BE DISCOVERED. THESE DRAWINGS AND SPECIFICATIONS DO NOT INCLUDE THE NECESSARY ELEMENTS FOR CONSTRUCTION SAFETY.
- CALL UNDERGROUND ALERT BEFORE YOU DIG.
- UTILITY CONTACTS:
(COORDINATE WITH ARCHITECT AND UTILITY CONSULTANT)
- MINIMUM CONDUIT SIZE SHALL BE 3/4" - U.O.N.
- MINIMUM CONDUCTOR SIZE SHALL BE #10 AWG. - U.O.N.
- ALL SITE BRANCH CIRCUITS SHALL INCLUDE A NEC SIZED EQUIPMENT GROUND CONDUCTOR.
- ALL ELECTRICAL EQUIPMENT MOUNTED OUTDOORS SHALL BE WEATHERPROOF (NEMA #3R).
- PROJECT ADDRESS.

SITE PLAN KEY NOTES


- (1) 500. FOR POWER SERVICE. AS DIRECTED BY UTILITY COMPANY.
- (2) 500. FOR POWER SERVICE. AS DIRECTED BY UTILITY COMPANY.
- (2) 400. TO POINT OF CONNECTION FOR TELEPHONE SERVICE. AS DIRECTED BY TELEPHONE COMPANY.
(1) 400. TO POINT OF CONNECTION FOR CATV SERVICE. AS DIRECTED BY CATV COMPANY.
- 1"=4'-0" & 1/8"=0'-0"
- 3/4"=2'-0" & 1/8"=0'-0"

LUMINAIRE SCHEDULE


Symbol	Label	Qty	Catalog Number	Description	Lamp	File	Lumens	LF	Watts
A	9	1	USA-APG-S19-V-16-500-SM-18-MFG	18" X 9" X 12" ARCADE SQUARE SPOREBOX WITH CUTOFF REFLECTOR, 16" SQ. X 2" - 38" DEEP CLEAR SAO GLASS LENS	250W E20A CLR PULSE START METAL HALIDE	APG-S19-V-16-25P-88	25000	0.72	280
B	4	1	USA-APG-S19-V-16-500-SM-18-MFG	18" X 9" X 12" ARCADE SQUARE SPOREBOX WITH CUTOFF REFLECTOR, 16" SQ. X 2" - 38" DEEP CLEAR SAO GLASS LENS	250W E20A CLR PULSE START METAL HALIDE	APG-S19-V-16-25P-88	25000	0.72	280

STATISTICS

Description	Symbol	Avg	Max	Min	Max/min	Avg/min
PARKING DRIVEWAY	+	3.71c	8.31c	1.01c	8.31	3.71

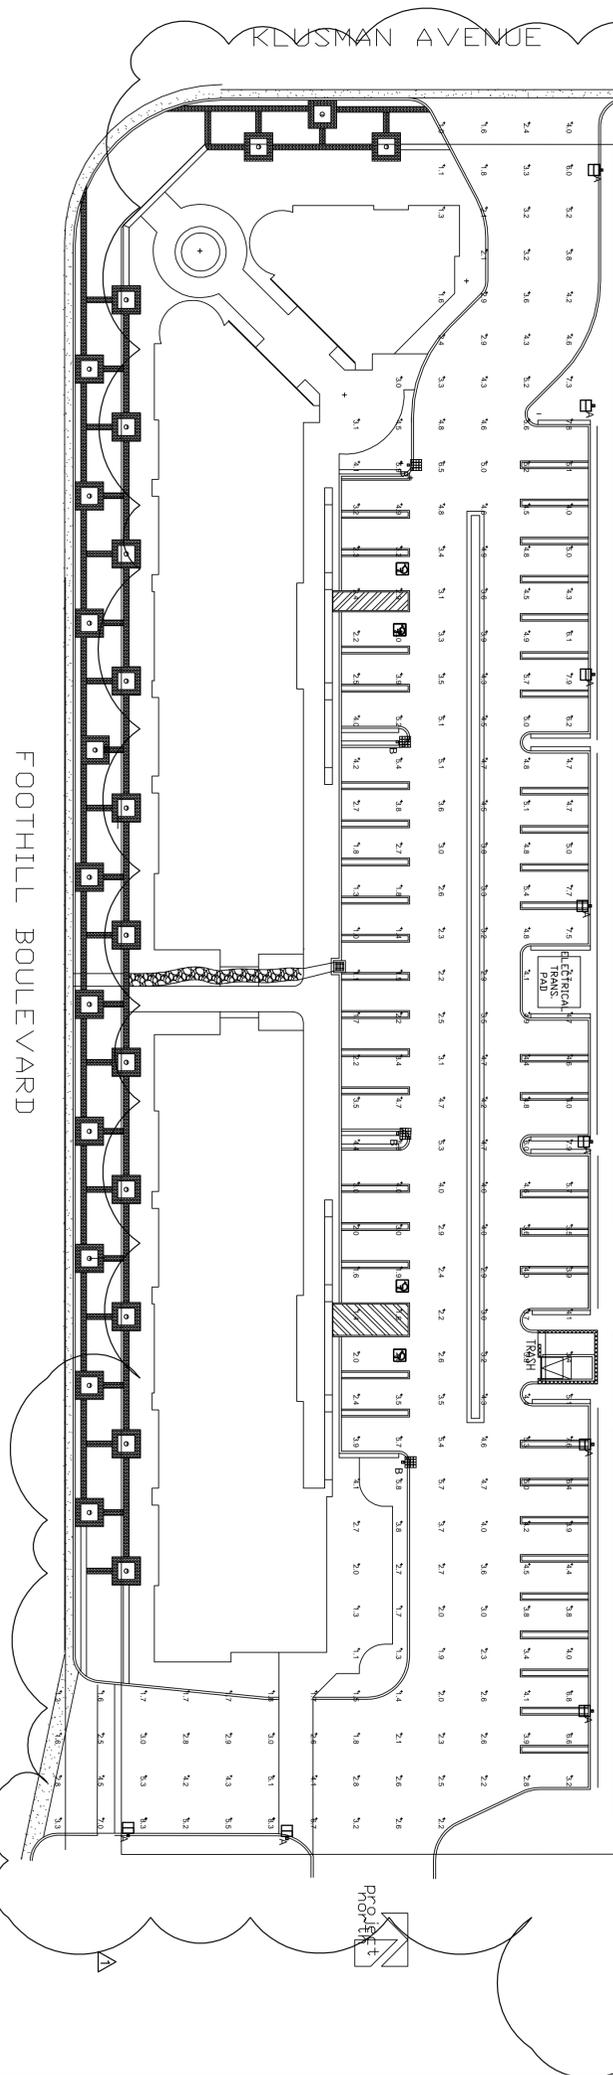

2 SITE LIGHTING PHOTOMETRIC PLAN
1/20" = 1'-0"

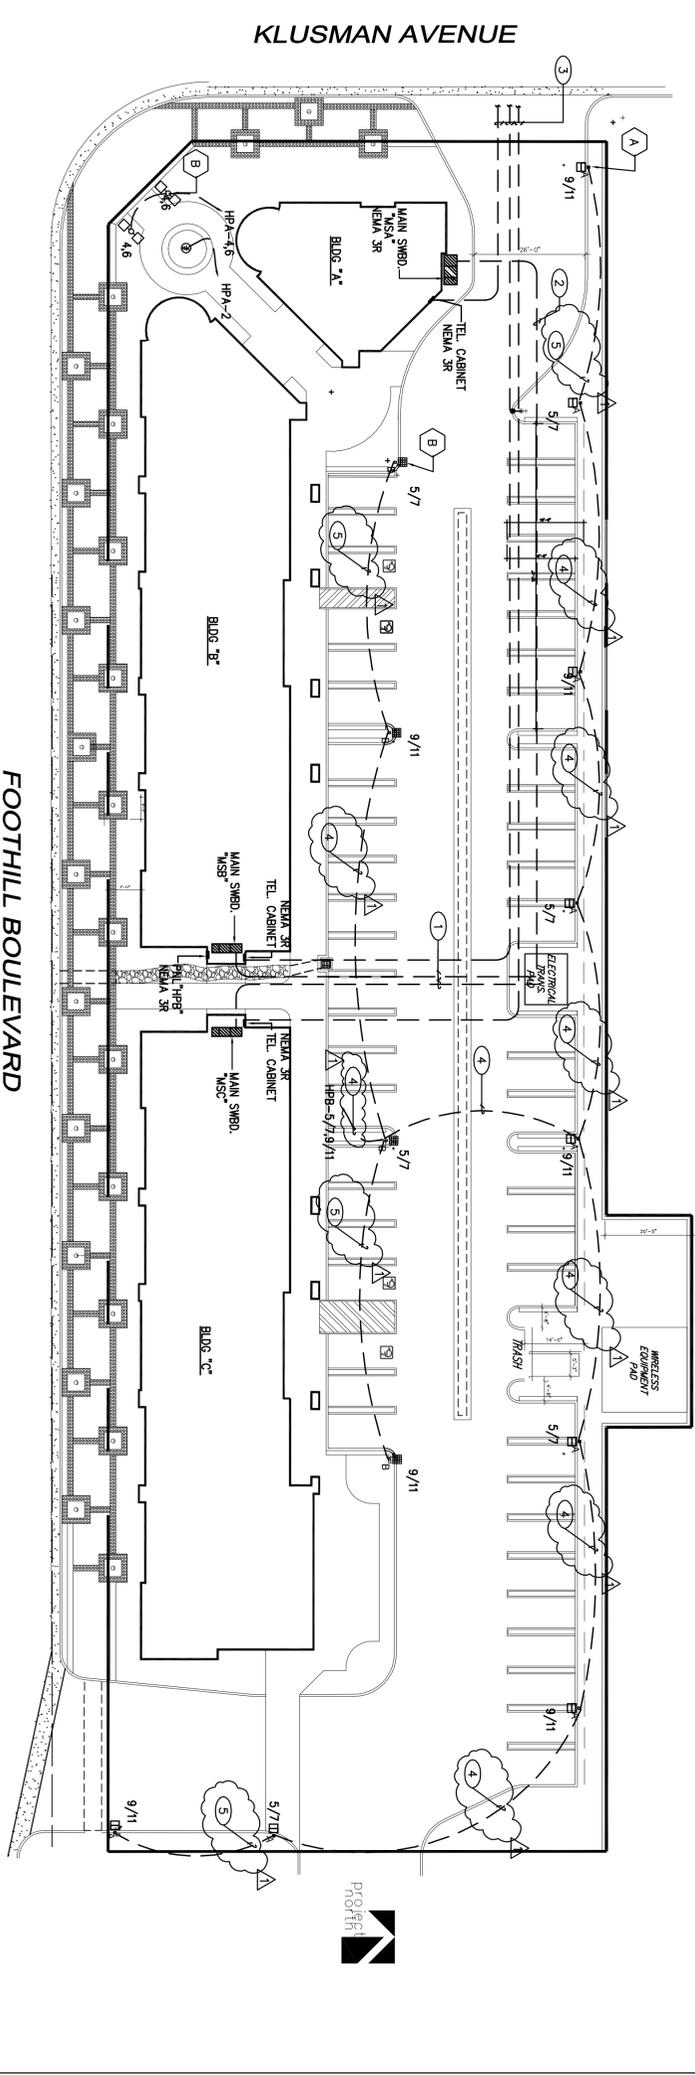

1 SITE PLAN
1/20" = 1'-0"

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PROJECT:
FOOTHILL RANCHO PLAZA
9606 FOOTHILL BLVD
RANCHO CUCAMONGA, CA

DEVELOPER:
CALIFORNIA LIBERTY INVESTMENTS
537 CERES AVE
LOS ANGELES, CA 90013

PROJECT NO.: GH-090504
CAD DWG FILE:
DRAWN BY: M.M.
CHECKED BY: G.B.
SCALE: NOTED
DATE: 09-08-09
SHEET TITLE:
SITE PLAN
SHEET
E1.0