


**GENERAL NOTES**


1. REFER TO ARCHITECTURAL DRAWINGS FOR EXACT LOCATION OF ALL ELECTRICAL OUTLETS, DEVICES AND MOUNTING HEIGHTS.
2. REFER TO MECHANICAL DRAWINGS FOR NUMBER AND LOCATION OF ALL MECHANICAL EQUIPMENT.
3. PROVIDE JUNCTION BOX AND 1/2" C.O. STUB-UP TO ACCESSIBLE CEILING SPACE AT EACH TERMINATION LOCATION. REFER TO MECHANICAL DRAWINGS FOR LOCATION.
4. NO EQUIPMENT, J-BOXES, ETC. REQUIRING ACCESS SHALL BE LOCATED IN HARD CEILING AREAS (UNLESS ACCESS PANEL IS PROVIDED, COORDINATE WITH ARCHITECT) RELOCATE ANY EXISTING EQUIPMENT, J-BOXES, ETC. TO ACCESSIBLE CEILING AREA.
5. ALL RECEPTACLES WITHIN 6 FEET NEAR SINK SHALL BE G.F.I. TYPE RECEPTACLE.
6. PROVIDE FINAL CONNECTION TO ALL EQUIPMENT INCLUDING EQUIPMENT PROVIDED BY OTHER TRADES, UNLESS INDICATED OTHERWISE.
7. ALL JUNCTION BOXES, RECEPTACLES AND SWITCHES SHALL BE LABELED WITH PANEL NAME & Ckt #.

**KEY NOTES**

- [1] 1' TO TEL. TO TEL. BOX.
- [2] 1" C.O. FOR CAVTY TO ELECTRICAL ROOM.

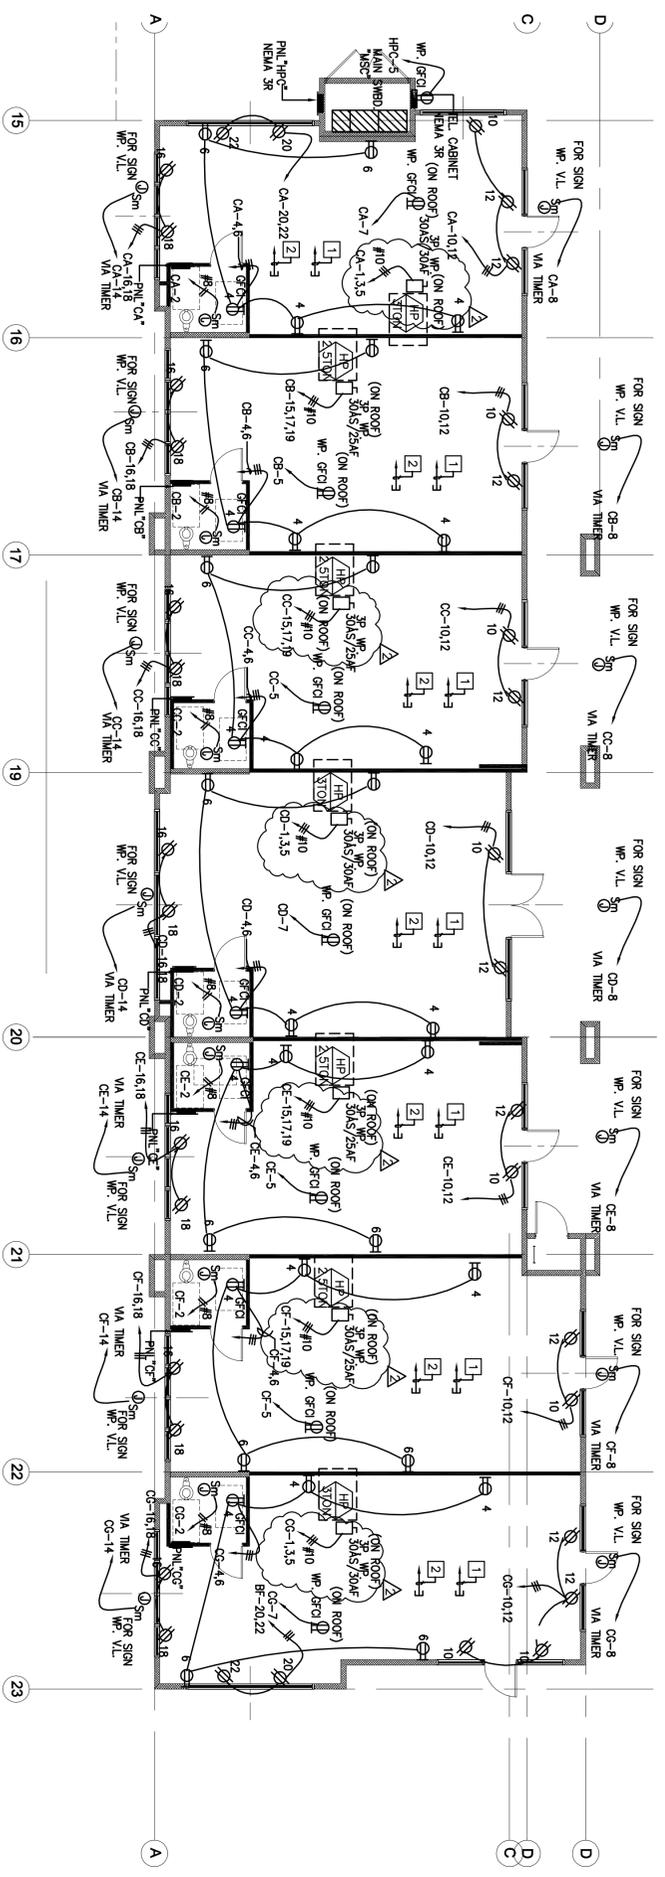

**1**  
POWER PLAN-BLDG "C"  
1/8" = 1'-0"

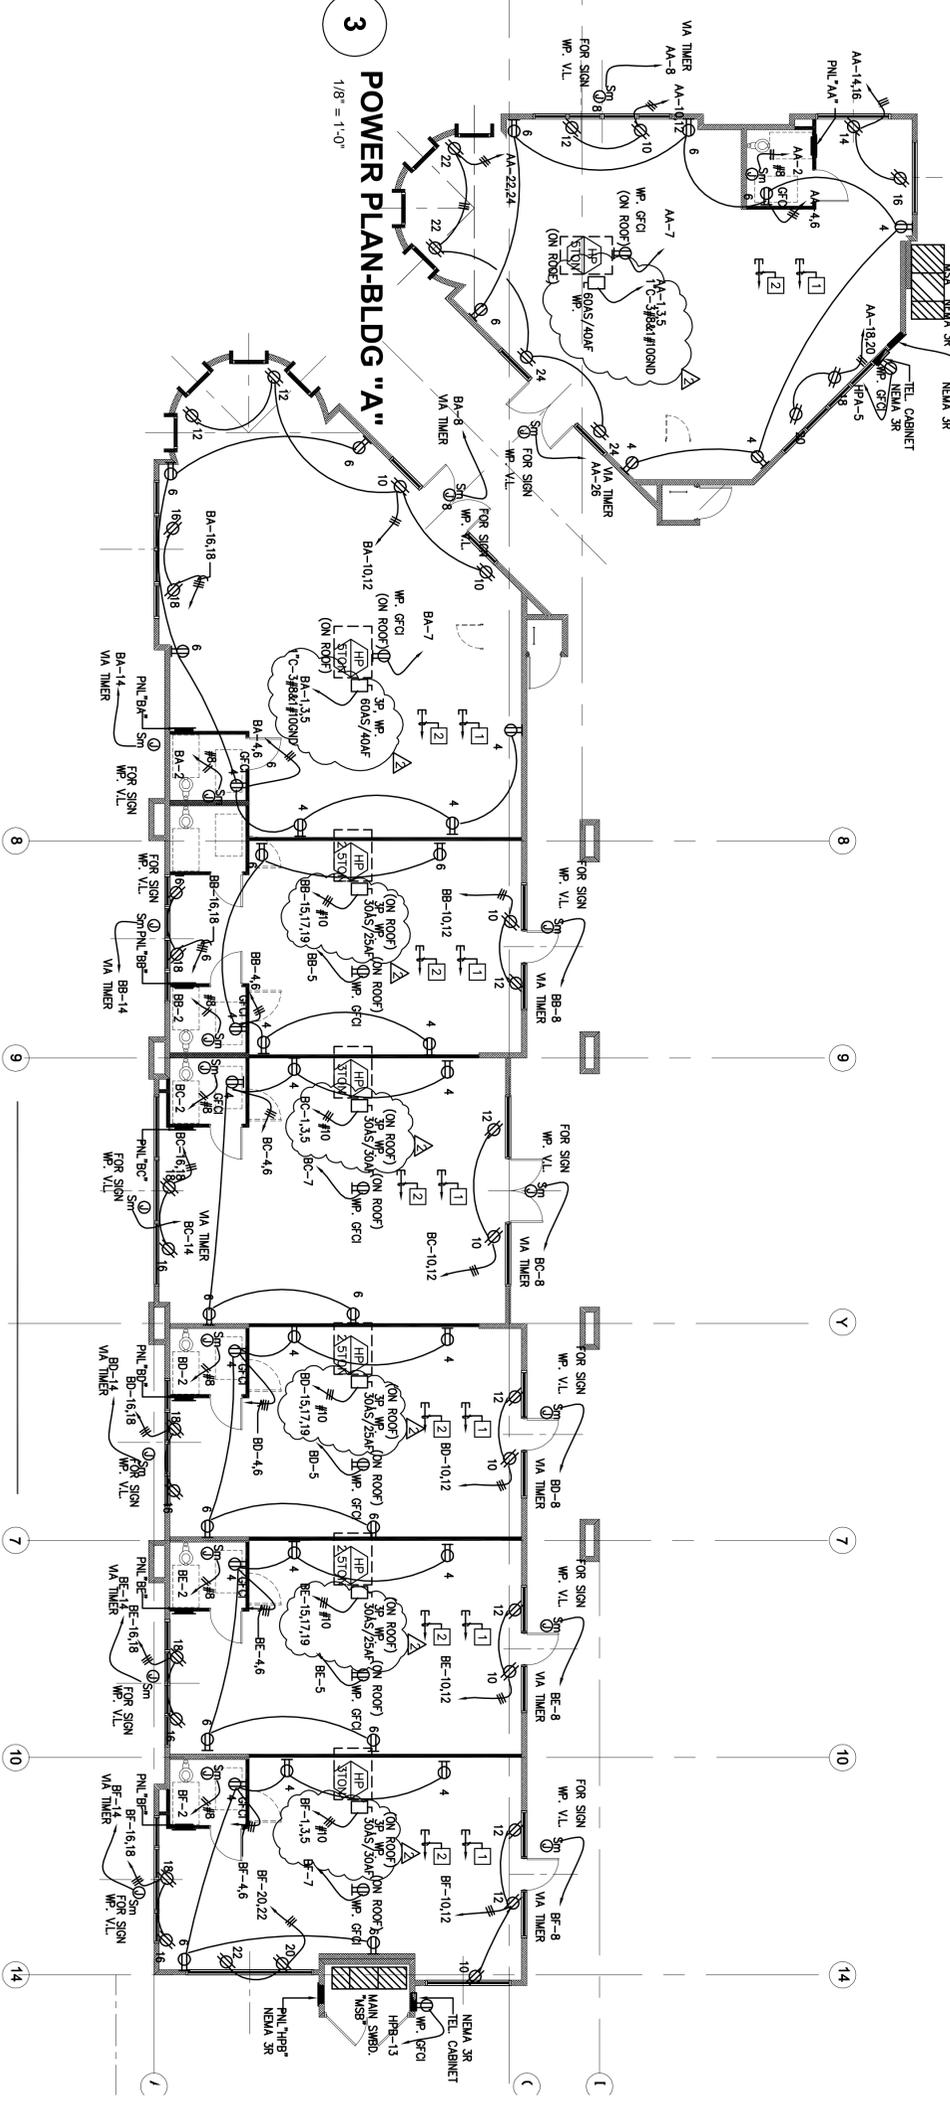

**2**  
POWER PLAN-BLDG "B"  
1/8" = 1'-0"

REVISIONS	DATE	BY	REV.

DEVELOPER:  
**CALIFORNIA LIBERTY INVESTMENTS**  
537 CERES AVE  
LOS ANGELES, CA 90013

PROJECT:  
**FOOTHILL RANCHO PLAZA**  
9606 FOOTHILL BLVD  
RANCHO CUCAMONGA, CA



**JN&B ENGINEERING, INC.**  
REGISTERED ELECTRICAL ENGINEERS  
14111 VAN COTT BLVD., SUITE 100  
ORANGE, CA 92667  
TEL: (714) 289-2621 FAX: (714) 289-2624

**GEORGE BEHNAME, AIA**  
ARCHITECT  
1150 E. ORANGETHORPE # 109  
PLACENTIA, CA 92870  
(714) 572-2384 FAX: (714) 572-2385

THESE DRAWINGS AND ACCOMPANYING SPECIFICATIONS, AS INSTRUMENTS OF THIS SERVICE, ARE THE EXCLUSIVE PROPERTY OF THE ARCHITECT. THEIR USE AND PUBLICATION SHALL BE RESTRICTED TO THE ORIGINAL SITE THEY WERE PREPARED FOR. REPRODUCTION OR PUBLICATION BY ANY MEANS IS PROHIBITED EXCEPT BY WRITTEN PERMISSION FROM THE ARCHITECT.

PROJECT NO.: CIL-090504  
LOAD DWG. FILE:  
DRAWN BY: M.M.  
CHECKED BY: C.B.  
SCALE: NOTED  
DATE: 09-08-09  
SHEET TITLE:

POWER PLAN  
SHEET  
E2.1